

June 7, 2021

To All Contractors Bidding On the:

THE CHURCH OF JESUS CHRIST OF LATTER DAY SAINTS

LDS PROJECT #514-3640

Addendum No. TWO is hereby made a part of the Contract Documents pertaining to the above project and shall be binding upon each entity submitting bids. It shall be the responsibility of each Contractor to notify the sub contractors, materialmen and suppliers concerning the contents of this Addendum as they specifically apply them.

<u>ITEM NO. 1:</u> See attached revision for window "A". Window mark "A" in unit 115 or #4 on the plans shall be replaced with a new vinyl window per attached elevation.


<u>ITEM NO. 2:</u> Contractor shall patch and repair existing construction as required by new renovation, ie: window head, jambs and sills, ceilings etc.

<u>ITEM NO. 3:</u> Contractor shall remove all exist. ceiling fans / light combo units and replace them with new light fixtures. Fixtures shall be Lithonia, FMLACL, Lacuna LED Flush Mount, 120v/ 4000k.

ITEM NO. 3: Mechanical Items: See attached revised Sheet M1. Revisions include but are not limited too:

- 1) Relocated controls for kitchen fans to the opposite wall of their previous location.
- 2) Shifted condensing units and electrical panels.
- 3) Added exhaust fan & roof cap schedules.

- End of Addendum 2 -

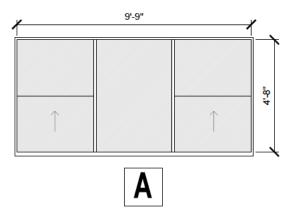


1 WINDOW ELEVATION

Scale: NTS




Window / wall elevation at Unit #4 – (113); Item No 1.


CEILING EXHAUST FAN DETAIL

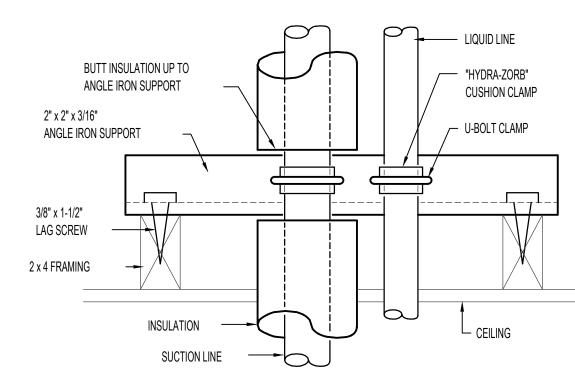


REFRIG. PIPING SUPPORT AT CEILING

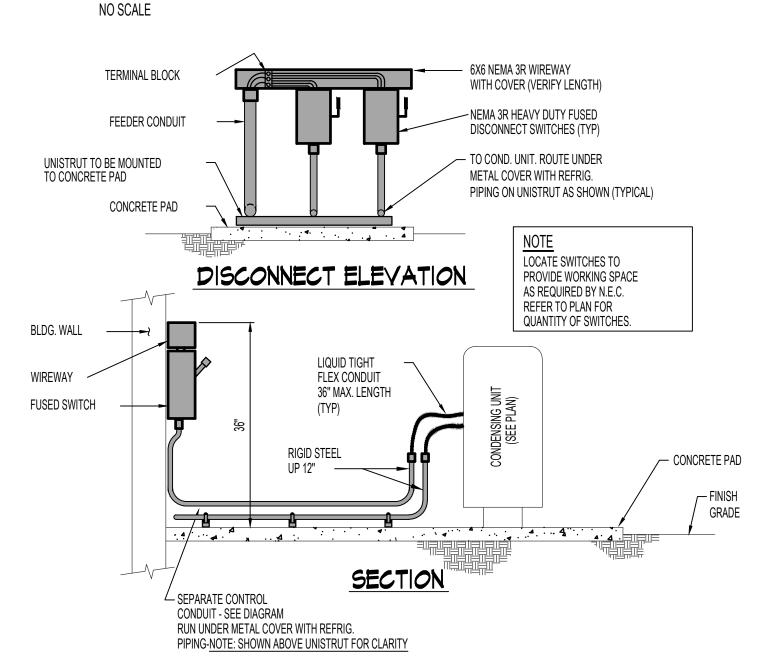

CONDENSING UNIT - CONDUIT DIAGRAM

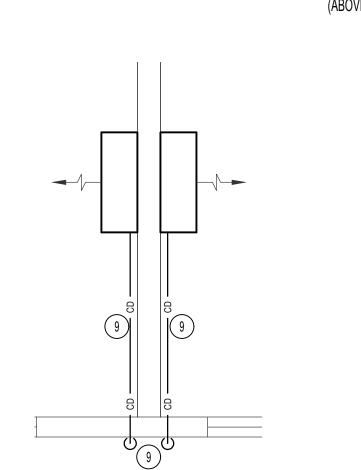


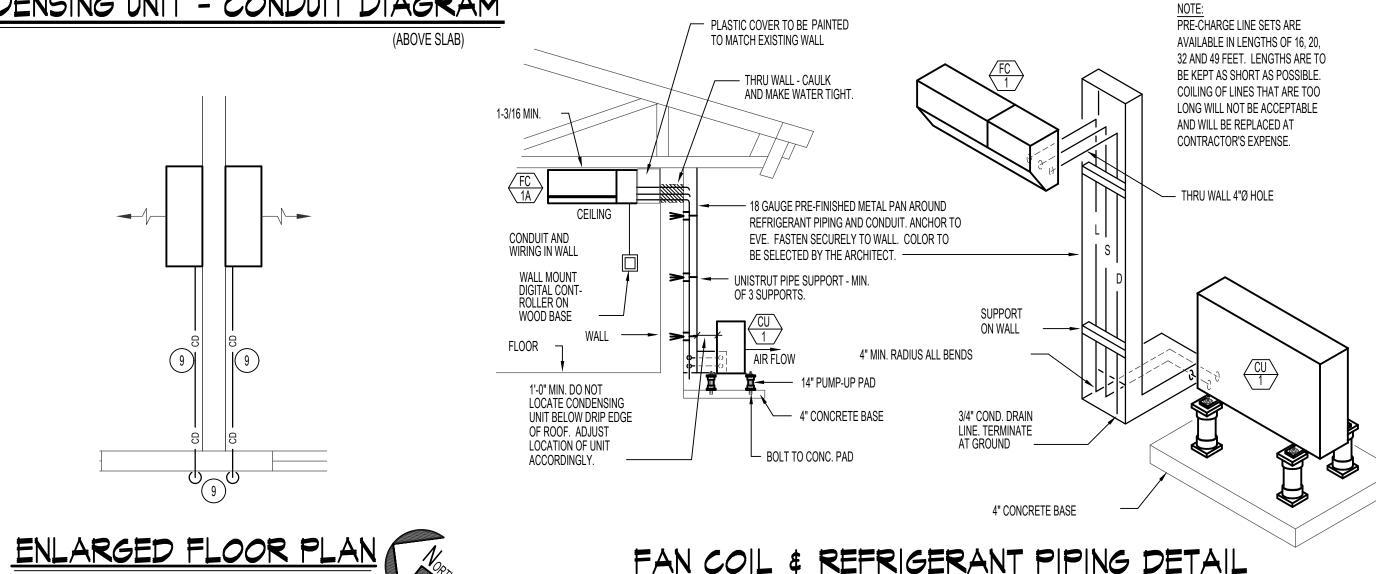

FAN COIL & REFRIGERANT PIPING DETAIL

KITCHEN KITCHEN BATH LAUNDRY LAUNDRY BEDROOM #2 BEDROOM #2 LIVING ROOM LIVING ROOM BEDROOM #1 BEDROOM #1 MECHANICAL DEMO PL

SCALE: 1/4" = 1'-0"

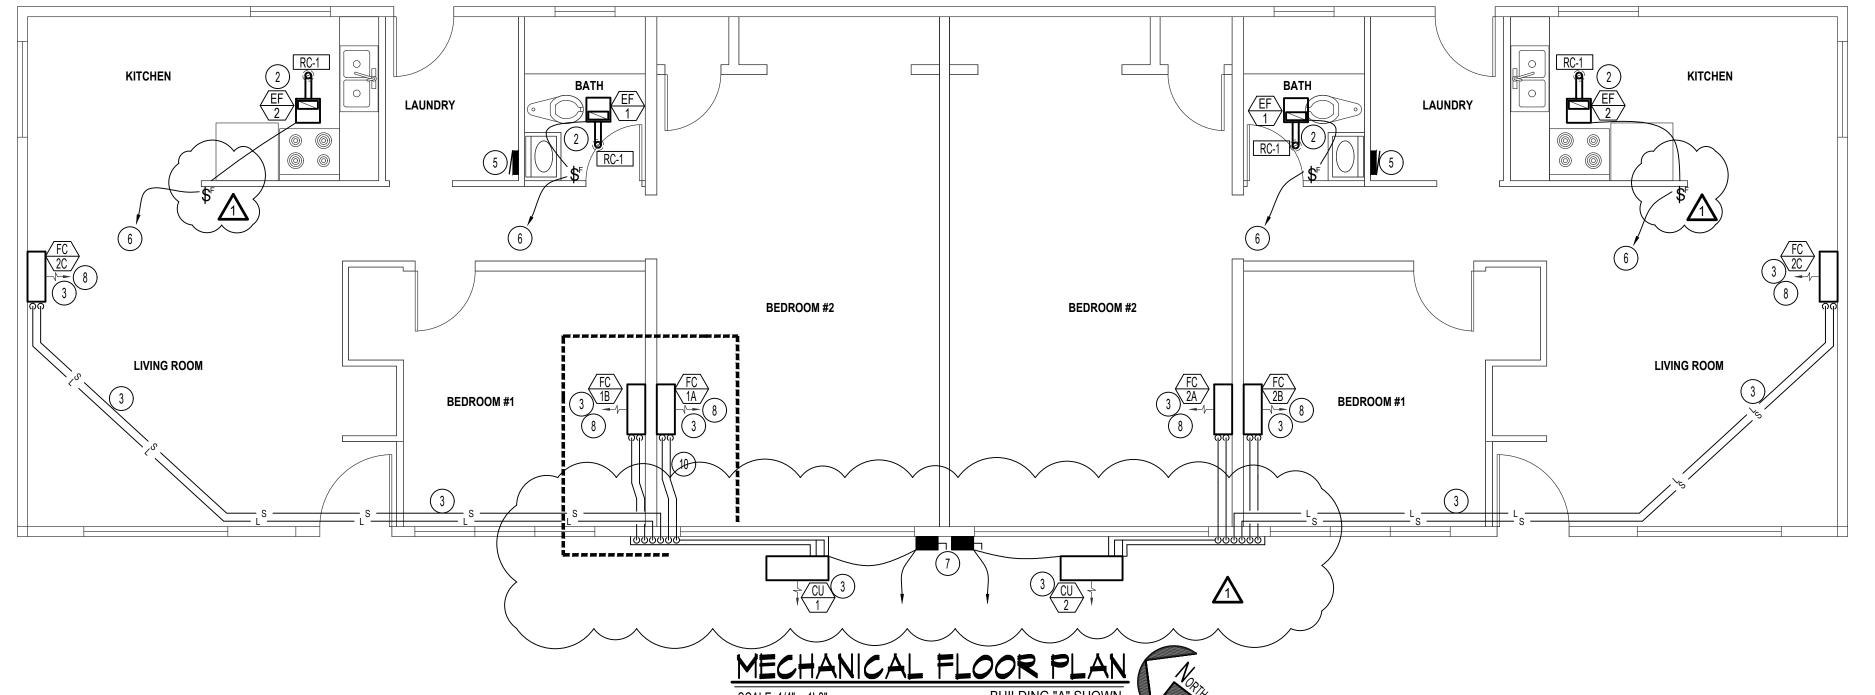

BUILDING "B" SIMILAR

GRILLE AND REGISTER SCHEDULE FIRE BALANCING **REMARKS** TYPE SIZE CONSTR. SYM. FINISH RANGE PATTERN DAMPER DAMPER TWIN CITY MODEL 634M W/ RC-1 ROOFCAP 6"Ø 100-200 ALUM. NA ALUM. INSECT SCREEN & BACK DRAFT

	EXHAUST FAN SCHEDULE											
S	SYM.	TYPE	C.F.M.	S.P.E.	WATTS	CHAR.	R.P.M.	CONTROL	REMARKS			
	EF 1	CEILING MOUNTED	100	.25	87	120/60/1	640	TIMER	TWIN CITY MODEL T100 WITH BACKDRAFT DAMPER. 6"Ø EXHAUST DUCT TO SLOPED ROOF CAP.			
\	EF 2	CEILING MOUNTED	200	.25	127	120/60/1	760	TIMER	TWIN CITY MODEL T200 WITH BACKDRAFT DAMPER. 6"Ø EXHAUST DUCT TO SLOPED ROOF CAP.			

FAN COIL SCHEDULE											
SYM.	CFM	EER	CHAR.	FAN WATTS	MCA	WEIGHT	COOLING CAPACITY	CONDENSATE DRAIN	REMARKS		
$\frac{\overline{FC}}{1A}$ THRU $\frac{\overline{FC}}{1C}$	237	13	240/60/1	30	7	22#	12,000 BTU	3/4"	MITSUBISHI M-SERIES MSZ-GL12NA WITH SEACOAST COATING		
$\frac{\overline{FC}}{2A}$ THRU $\frac{\overline{FC}}{2C}$	237	13	240/60/1	30	7	22#	12,000 BTU	3/4"	MITSUBISHI M-SERIES MSZ-GL12NA WITH SEACOAST COATING		

CONDENSING UNIT SCHEDULE COOLING ONLY REQUIRED											
SYM.	BTU	EAT	CHAR.	MCA	MOCP	WEIGHT	REFRIGEF LIQUID	RANT PIPING SUCTION	- REMARKS		
CU 1	36,000	95°F	240-1Ø	22.1	25	140#	1/4"	3/8"	MITSUBISHI ELECTRIC M-SERIES MODEL MXZ-4C36NA2 WITH OPTIONAL SEACOAST COATING. SEER 19.2		
CU 2	36,000	95°F	240-1Ø	22.1	25	140#	1/4"	3/8"	MITSUBISHI ELECTRIC M-SERIES MODEL MXZ-4C36NA2 WITH OPTIONAL SEACOAST COATING. SEER 19.2		


PLAN NOTES:

- 1) REMOVE AND DISPOSE OF EXISTING WINDOW TYPE A/C UNITS.
- PROVIDE AND INSTALL NEW EXHAUST FAN IN THIS LOCATION.
- SEE THIS SHEET FOR TYPICAL INSTALL DETAILS. INSTALL NEW MINI SPLIT IN LOCATION AS SHOWN. RUN REFRIGERATION LINES UP OUTSIDE WALL TO ATTIC SPACE AND
- COVER AS PER DETAILS. RUN THRU ATTIC TO NEW INDOOR UNITS. SEE REFRIGERATION COVER ON THIS SHEET. RE-USE EXISTING REFRIGERANT LINES AS NEEDED. FIELD VERIFY BEST POSSIBLE ROUTES AND LOCATIONS FOR NEW EQUIPMENT. REPLACE VIBRATION PADS FOR NEW CONDENSING UNIT.
- (4) EXISTING WINDOW UNIT RATHER THAN SPLIT SYSTEM FOR OTHER SIMILAR BUILDING.
- 5) EXISTING ELECTRICAL PANEL TO REMAIN. REPLACE EXISTING 20A 2P BREAKER WITH NEW 30A 2P BREAKER.
- 6) INSTALL NEW SWITCH ON WALL AND CONNECT TO UN-SWITCHED

POWER CIRCUIT TO CONTROL NEW EXHAUST FAN.

- REPLACE EXISTING DISCONNECT WITH NEW NEMA 3R 30A 2P FUSED DISCONNECT. FUSE AT 25 A. RUN 10/3 ROMEX TO PANEL FOR NEW A/C UNIT.
- 8) INDOOR UNITS RECEIVE POWER FROM CONDENSING UNITS DISCONNECT. RUN WIRE AS PER MANUFACTURES RECOMMENDATION.
- heta) Run 3/4" condensate drain line out to nearest wall and DROP THE LINE TO APPROXIMATELY 1' FROM SLAB. SEAL PENETRATION WEATHER TIGHT. INSTALL BEHIND REFRIGERATION COVER OR COVER WITH NEW. SIMILAR INSTALI FOR OTHER UNITS.



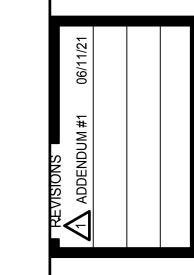

RENOVATION

HOUSE

AIE MISSION


HRIS⁻

SUS


GENERAL NOTES:

- THE CONTRACTOR SHALL CHECK AND VERIFY ALL DIMENSIONS AND CONNECTIONS ON THE JOB SITE. ALL WORK SHALL BE EXECUTED FROM MEASUREMENTS TAKEN AT THE SITE.
- THE MECHANICAL CONTRACTOR SHALL BE RESPONSIBLE TO INSURE PROPER CODE CLEARANCES FOR ELECTRICAL AND MECHANICAL ACCESS WHEN INSTALLING ANY EQUIPMENT SUPPLIED BY THE MECHANICAL CONTRACTOR.
- IT IS CRITICAL THAT THIS CONTRACTOR COORDINATE EQUIPMENT LOCATIONS WITH PIPING, DUCTWORK, ELECTRICAL CONDUIT AND BUILDING STRUCTURE TO INSURE CODE COMPLIANCE.
- CEILING DIFFUSERS ARE SHOWN IN APPROXIMATE LOCATIONS. REFER TO LIGHTING PLANS AND REFLECTED CEILING PLAN FOR EXACT LOCATIONS.
- DUCT DIMENSIONS CALLED OUT ON DRAWINGS ARE INSIDE FREE AREA DIMENSIONS. ACOUSTICAL DUCT LINER ARE TO BE ADDED TO OVERALL MEASUREMENTS.

THIS WORK WAS PREPARED BY ME OR UNDER MY SUPERVISION AND CONSTRUCTION OF THIS PROJECT WILL BE UNDER MY OBSERVATION

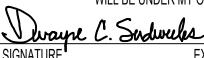

4/30/2022 EXPIRATION DATE OF THE LICENSI

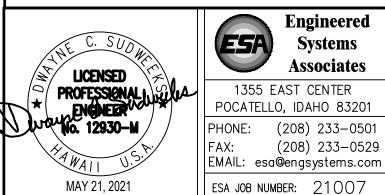



(208) 233-0529

DRAWN BY: TCD

CHECKED: DCS

ROJECT NO.: 21007